

Consultant  
Address  
Address  
Address  
Phone

Consultant  
Address  
Address  
Address  
Phone

Consultant  
Address  
Address  
Address  
Phone

Consultant  
Address  
Address  
Address  
Phone

Consultant  
Address  
Address  
Address  
Phone

Consultant  
Address  
Address  
Address  
Phone

Window Schedule						
Count	Height	Width	Family and Type	Mark	Sill Height	Family
1	6'-0"	2'-0"	Double Hung-24" x 72"	1	1'-0"	Double Hung
1	6'-0"	2'-0"	Double Hung-24" x 72"	2	1'-0"	Double Hung
1	6'-0"	2'-0"	Double Hung-24" x 72"	3	1'-0"	Double Hung
1	6'-0"	2'-0"	Double Hung-24" x 72"	4	1'-0"	Double Hung
1	6'-0"	2'-0"	Double Hung-24" x 72"	5	1'-0"	Double Hung
1	6'-0"	2'-0"	Double Hung-24" x 72"	6	1'-0"	Double Hung
1	6'-0"	2'-0"	Double Hung-24" x 72"	7	1'-0"	Double Hung
1	6'-0"	2'-0"	Double Hung-24" x 72"	8	1'-0"	Double Hung
1	6'-0"	2'-0"	Double Hung-24" x 72"	11	1'-0"	Double Hung
1	6'-0"	2'-0"	Double Hung-24" x 72"	12	1'-0"	Double Hung
1	6'-0"	2'-0"	Double Hung-24" x 72"	13	1'-0"	Double Hung
1	6'-0"	2'-0"	Double Hung-24" x 72"	14	1'-0"	Double Hung

No.	Description	Date

Door Schedule								
Width	Mark	Height	Keynote	Assembly Code	Assembly Description	Count	Family and Type	Thickness
3'-0"	1	7'-0"		C1020	Interior Doors	1	Single-Flus In: 36" x 84"	0'-2"
3'-0"	2	7'-0"		C1020	Interior Doors	1	Single-Flus In: 36" x 84"	0'-2"
3'-0"	3	7'-0"		C1020	Interior Doors	1	Single-Flus In: 36" x 84"	0'-2"
5'-6"	4	6'-8"		C1020	Interior Doors	1	Double-Flus In: 68" x 80"	0'-2"
2'-6"	5	6'-8"		C1020	Interior Doors	1	Single-Raised Panel with Sideights: 30" x 80"	0'-2"



**Benjamin Zisman**

**BIM A3**  
**Revit Test**

Project Number: **Assignment 3**  
Date: **5/1/08**  
Drawn By: **Benjamin Zisman**  
Checked By: **Jim Mitchell**



**A3**

Scale: **1/8" = 1'-0"**

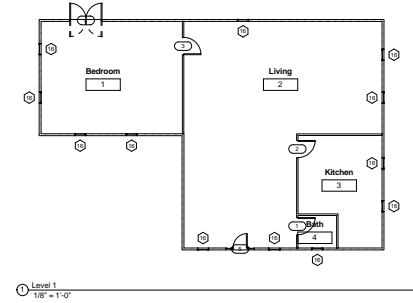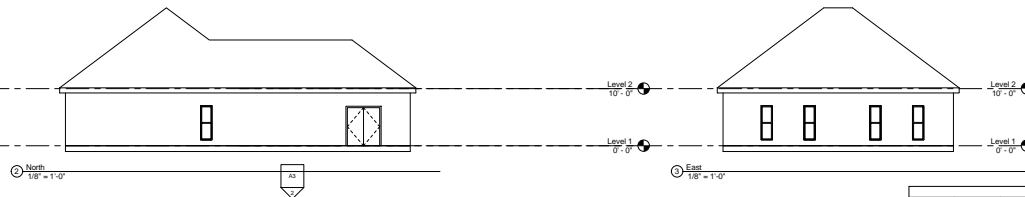

A3

A3

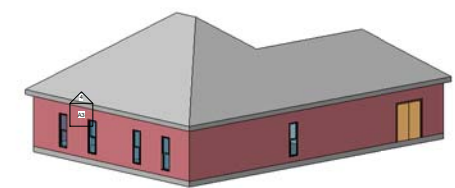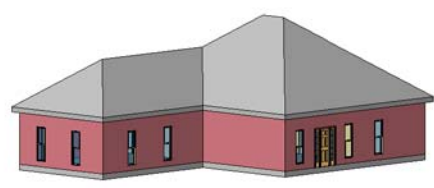

LIB1

Copy of (3D)